## GENERAL NOTES:

IN GENERAL, WORK SHALL INCLUDE, BUT NOT BE LIMITED TO:

- 1) THE DETAILED DESIGN, FABRICATION, PROCUREMENT, AND INSTALLATION OF THE FIRE PROTECTION SYSTEMS ADDITIONS AND MODIFICATIONS AS INDICATED ON THE CONTRACT DRAWINGS. THE FIRE PROTECTION SYSTEM MODIFICATIONS CONSIST OF THE ADDITION OCCUPANT NOTIFICATION APPLIANCES AND THE REPLACEMENT OF EXISTING OCCUPANT NOTIFICATION APPLIANCES. ALL NEW AND REPLACED APPLIANCES SHALL BE HORN, HORN/STROBE, OR STROBE, A INDICATED IN THE DRAWINGS.
- 2) INSTALLATION OF NEW CONDUIT, RACEWAY SYSTEM MODIFICATIONS, AND RACEWAYS, AND THE CONTROL UNIT MODIFICATIONS FOR THE FIRE ALARM SYSTEM MODIFICATIONS.
- 3) ALL PENETRATIONS THROUGH WALLS, FLOORS AND CEILINGS NECESSARY FOR THE INSTALLATION OF THE FIRE PROTECTION SYSTEMS INCLUDING THE INSTALLATION OF APPROVED FIRESTOP ASSEMBLIES NECESSARY TO MAINTAIN THE DESIGNED FIRE RESISTANCE RATING OF THE WALL, CEILING, OR FLOOR ASSEMBLY.
- 4) SYSTEMS AND DEVICE TESTING.
- 5) THE SUBCONTRACTOR SHALL BE RESPONSIBLE FOR ESTABLISHING AND IMPLEMENTING ALL SAFETY PROGRAMS AND PROCEDURES FOR THIS PROJECT AND SHALL COMPLY WITH ALL FEDERAL, STATE AND LOCAL SAFETY AND HEALTH REGULATIONS.
- 6) THE CONTRACT DRAWINGS ARE DIAGRAMMATIC ONLY. SUBCONTRACTOR SHALL DETERMINE THE ACTUAL MEASUREMENTS AND MAKE ANY AND ALL SUCH LENGTH AND OFFSET ADJUSTMENTS AND FIRE ALARM CONTROL UNIT PROGRAMMING AS MAY BE NECESSARY TO COMPLETE THE INSTALLATION AT NO CHANGE IN THE CONTRACT PRICE. THE DRAWINGS ARE NOT INTENDED TO RELIEVE THE SUBCONTRACTOR OF ANY RESPONSIBILITY FOR AVOIDING CONFLICTS OR OBSTRUCTIONS, OR FOR INSTALLING THE FIRE ALARM DEVICES AND EQUIPMENT AS REQUIRED TO PROVIDE COMPLETE PROTECTION OF THE DESIGNATED AREAS IN ACCORDANCE WITH THE REQUIREMENTS OF THE REFERENCED STANDARDS AND THE SPECIFICATIONS. WRITTEN APPROVAL SHALL BE OBTAINED FROM THE OWNER'S REPRESENTATIVE PRIOR TO MAKING ANY MAJOR DEVIATIONS FROM THE ARRANGEMENT AND LAYOUT SHOWN ON THE DRAWINGS.
- 7) ALL EQUIPMENT SHALL BE NEW, AND APPROVED AND/OR LISTED BY UNDERWRITERS' LABORATORIES OR FACTORY MUTUAL.
- 8) SYSTEM, EQUIPMENT, INSTALLATION, AND MATERIALS AND METHODS USED SHALL COMPLY WITH THE FOLLOWING:
  - A) THE REQUIREMENTS OF THE LAWRENCE BERKELEY NATIONAL LABORATORY.
  - NATIONAL FIRE PROTECTION ASSOCIATION (NFPA) 72 NATIONAL FIRE ALARM CODE, CURRENT EDITION.
  - CALIFORNIA BUILDING AND FIRE CODES, 2007 EDITIONS.
  - MANUFACTURER'S RECOMMENDATIONS AND GUIDELINES.

NOTIFICATION APPLIANCE CIRCUIT					
POWER REQUIREMENTS					
		# OF APPLIANCES			
DESCRIPTION	CURRENT PER APPLIANCE	CIRCUIT AV1	CIRCUIT AV2	CIRCUIT AV3	CIRCUIT AV4
WHEELOCK EXCEDER STROBE 15 cd	0.057	5	7	0	0
WHEELOCK EXCEDER HORN/STROBE 15 cd	0.082	0	0	0	0
WHEELOCK EXCEDER STROBE 30 cd	0.085	1	3	1	1
WHEELOCK EXCEDER HORN/STROBE 30 cd	0.102	2	1	2	1
WHEELOCK EXCEDER STROBE 75 cd	0.135	2	0	3	0
WHEELOCK EXCEDER HORN/STROBE 75 cd	0.148	1	1	3	1
WHEELOCK EXCEDER STROBE 110 cd	0.182	1	0	0	0
WHEELOCK EXCEDER HORN/STROBE 110 cd	0.197	0	0	0	2
WHEELOCK EXCEDER HORN	0.064	0	0	0	1
TOTAL CIF	CUIT CURRENT	1.174	0.904	1.138	0.793

- THE FOLLOWING NOTIFICATION APPLIANCES AND THEIR POWER DEMANDS WERE USED IN THE DESIGN:
- 1. COOPER NOTIFICATION, WHEELOCK EXCEDER SERIES; 15CD (0.057 AMP), 30CD (0.085 AMP), 75CD (0.135 AMP) & 110CD (0.182 AMP) WALL MOUNTED STROBE; RATED 8 TO 33 AMP.
- 2. COOPER NOTIFICATION, WHEELOCK EXCEDER SERIES; 15CD (0.082 AMP), 30CD (0.102 AMP),
- 75CD (0.148 AMP) & 110CD (0.197 AMP) WALL MOUNTED HORN/STROBE; RATED 8 TO 33 AMP. 3. COOPER NOTIFICATION, WHEELOCK EXCEDER SERIES; WALL MOUNTED HORN (0.064 AMP); RATED

## VOLTAGE DROP CALCULATIONS

I = CIRCUIT POWER LOAD21.6 = CONSTANT

D = CONDUCTOR ONE WAY DISTANCE CM = CROSS SECTION AREA OF WIRE (4110 FOR AWG#14)


{1.174 AMP) (500 FT) (21.64)}/4110 VOLTAGE DROP: 3.091 VOLTS AVAILABLE VOLTAGE: 20.909 VOLTS


{(0.904 AMP) (500 FT) (21.64)}/4110 VOLTAGE DROP: 2.380 VOLTS AVAILABLE VOLTAGE: 21.620 VOLTS

{(1.138 AMP) (500 FT) (21.64)}/4110 VOLTAGE DROP: 2.996 VOLTS AVAILABLE VOLTAGE: 21.004 VOLTS

{(0.793 AMP) (500 FT) (21.64)}/4110 VOLTAGE DROP: 2.088 VOLTS AVAILABLE VOLTAGE: 21.912 VOLTS

THE CIRCUITS' AVAILABLE VOLTAGE IS ABOVE THE MINIMUM LISTED VOLTAGE FOR THE APPLIANCES.

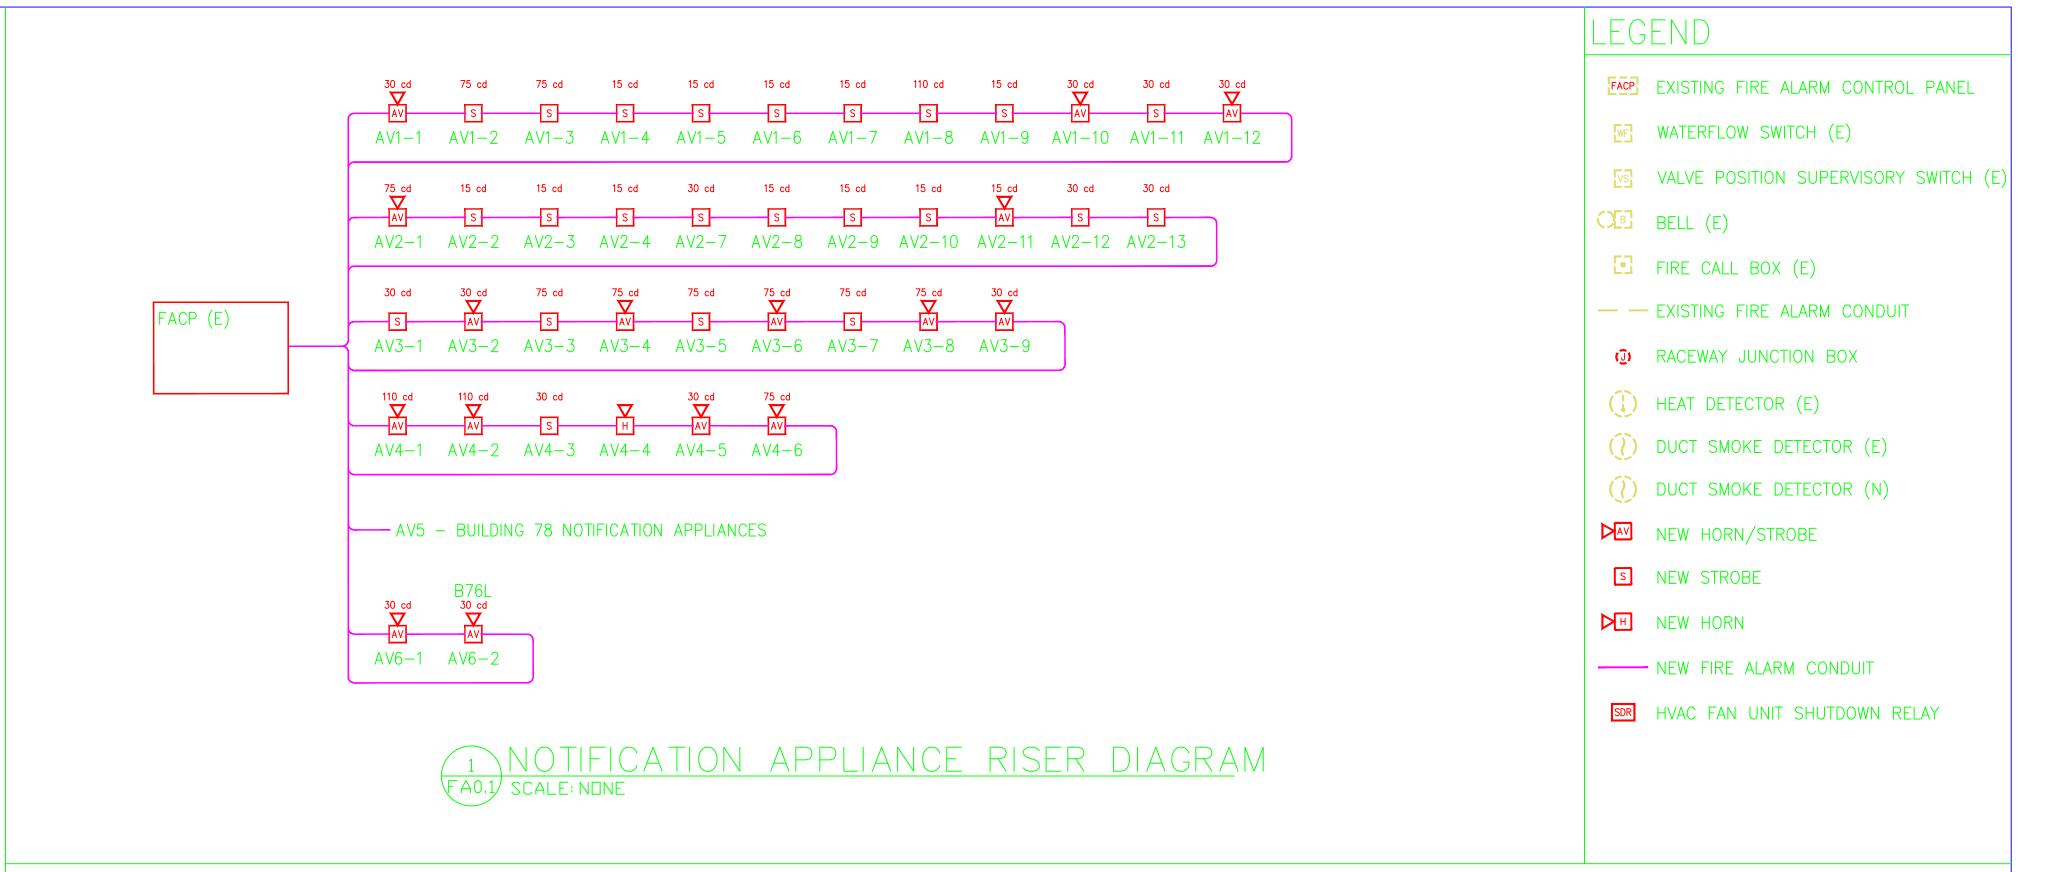

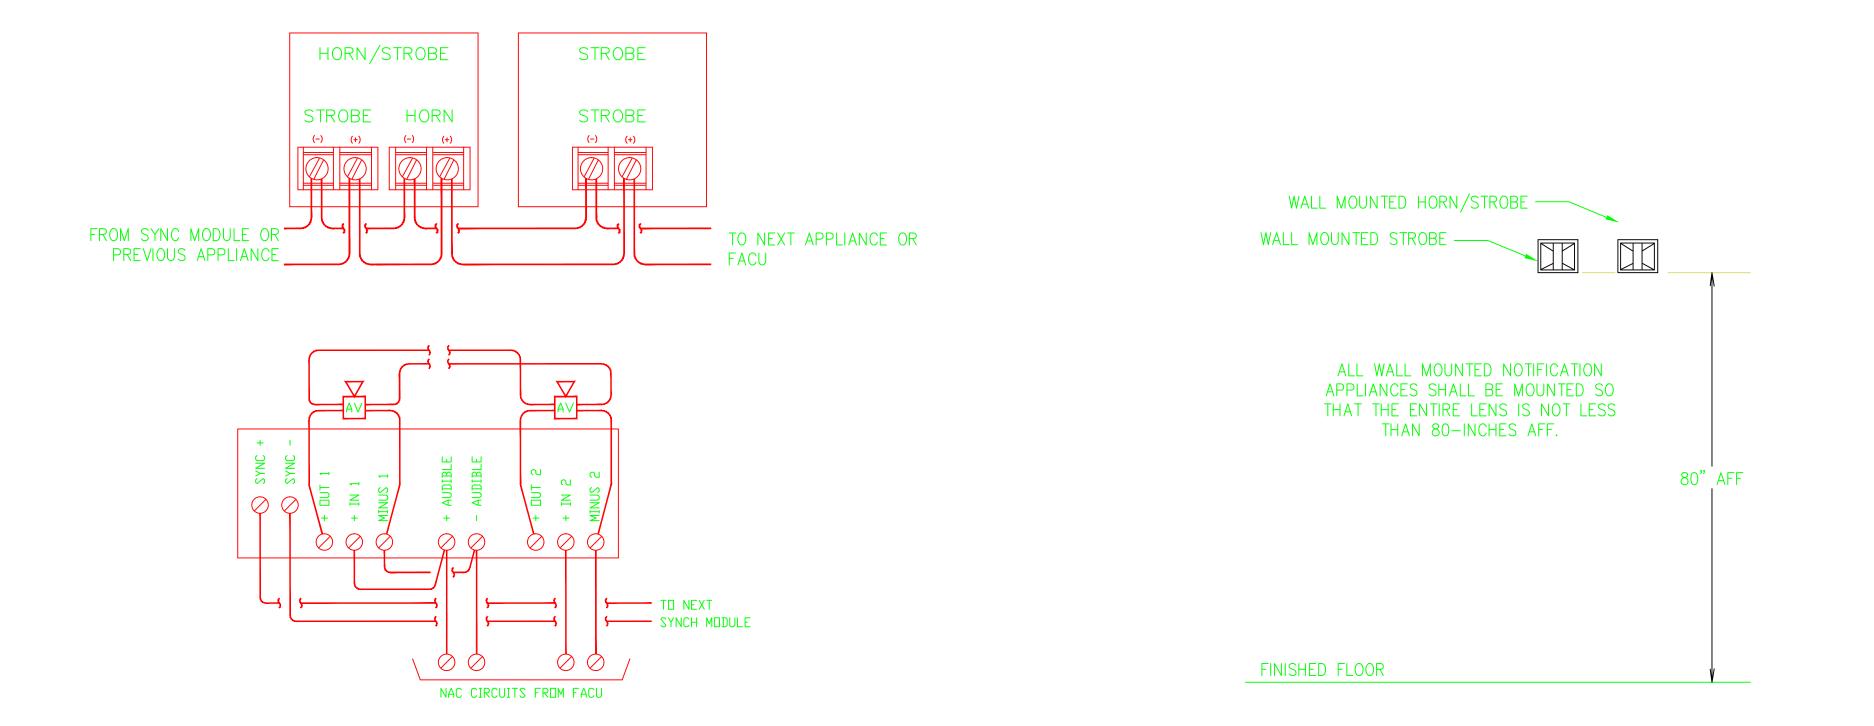





()	ISSUE (PROGRESS, ESTIMATE, BID, CONSTRUCTION, CONFORMED, REVISION, AS-BUILT)	REVISION NUMBER	DRAWN BY	CHECKED BY	APPR'D BY	DATE	REMARKS
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	00/00/00						
	06/08/09						
	DIVITINO						
	DRAWING						
	RECORD						
	DECODE						

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NOTE	S, LEGEND & DETAILS
FIRE	ALARM SYSTEM MODIFICATIONS
76	



SCALE As Noted DRAWING NO.

SHEET

CONSULTING FIRM

CONSULTING FIRM

PROFESSIONAL SEAL (IF REVISION, APPLIES ONLY TO REVISED WORK)

UNIVERSITY OF CALIFORNIA LAWRENCE BERKELEY NATIONAL LABORATORY FACILITIES DIVISION PROJECT NO. FP8200